

MBD-2010
H.P. SLUG CATCHER
72" O.D. x 20'-0" S/S
MAWP: 1480 PSIG @ 100°F

MBD-2020
CONDENSATE SURGE TANK
72" O.D. x 20'-0" S/S
MAWP: 285 PSIG @ 100°F

MBD-2030
L.P. SEPARATOR
72" O.D. x 20'-0" S/S
MAWP: 285 PSIG @ 100°F

NBK-2110/2120
OIL TREATERS
72" O.D. x 20'-0" S/S
MAWP: 105 PSIG @ 180°F

CZZ-4100
FLASH GAS COMPRESSOR
500 HP

CZZ-4200
VAPOR RECOVERY UNIT
100 HP


ABJ-5010/5020
GOOD OIL STORAGE TANK
40'-0" O.D. x 24'-0"H
CAPACITY: 5,000 BBL
API 650

ABJ-7010
PRODUCED WATER TANK
12'-0" O.D. x 20'-0"H
CAPACITY: 400 BBL
API 12F

ABJ-5510
BAD OIL TANK
12'-0" O.D. x 20'-0"H
CAPACITY: 400 BBL
API 12F

ZZZ-5210/5220
TRUCK LOADING LACTS

MBF-4550
FLASH GAS COMPRESSOR
DISCHARGE SCRUBBER
24" O.D. x 10'-0" S/S
MAWP: 1480 PSIG

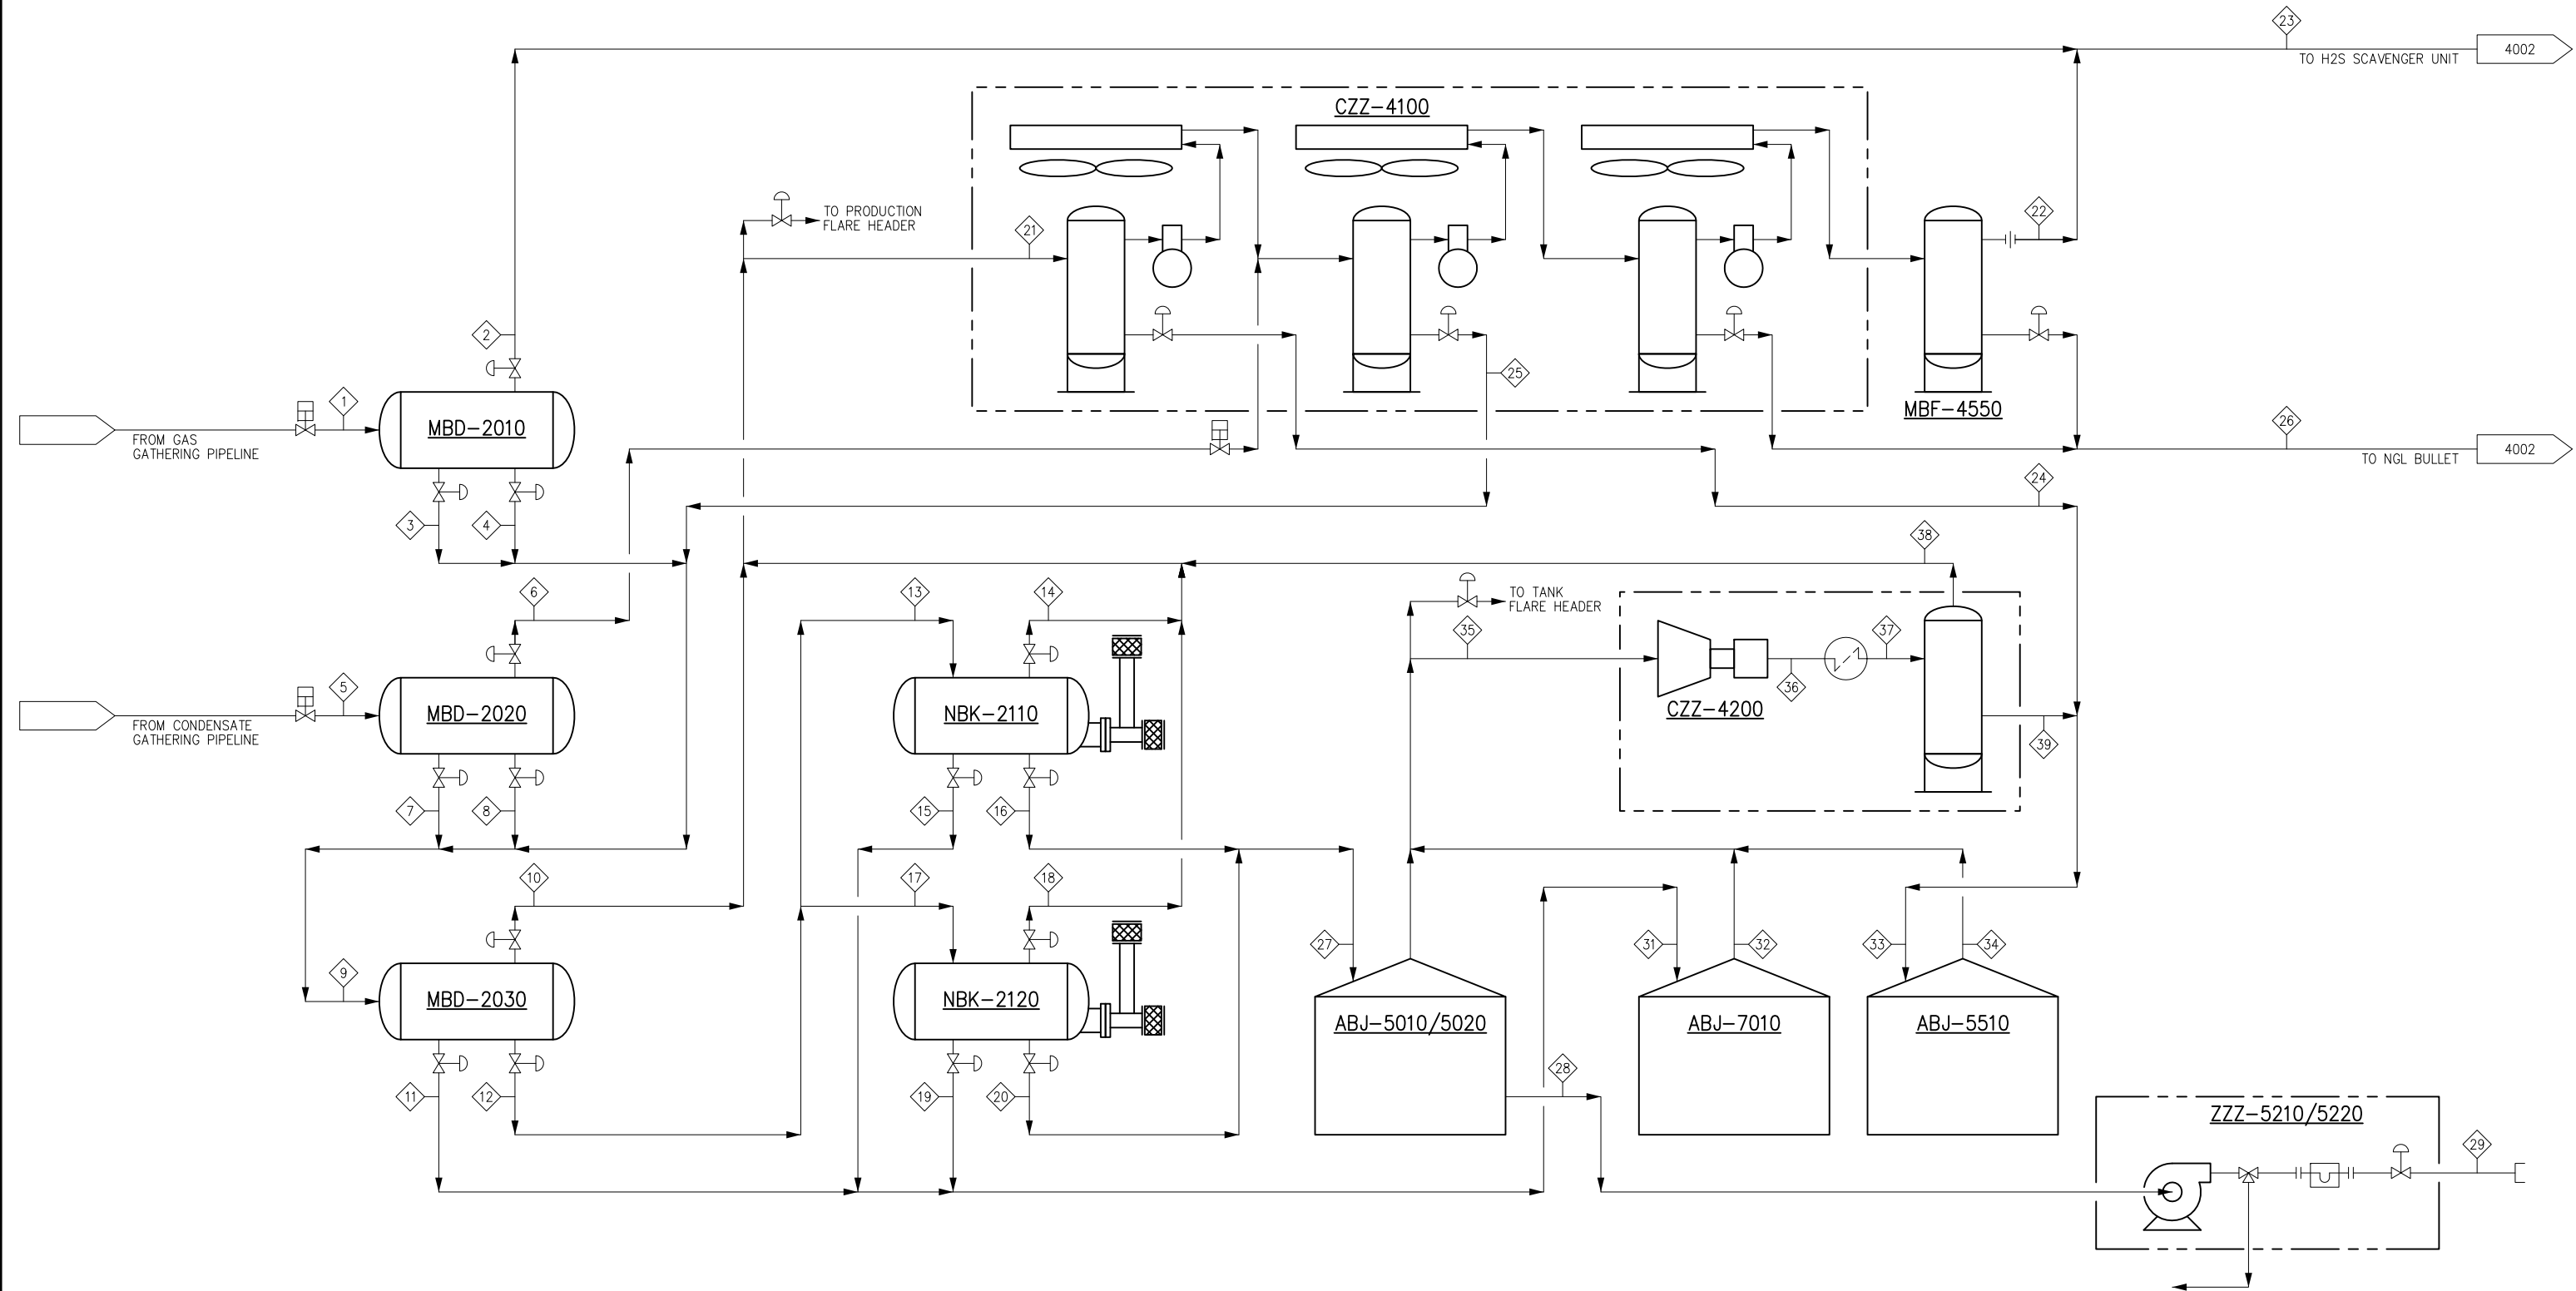

NOTES:

REV.	REVISION PURPOSE	BY	CHK	APP	DATE	CLIENT	DATE
A	ISSUED FOR REVIEW	SAV	KLS	KLS	02/17/14		

SEAL



SCALE: NTS
JOB NO.: 13429
DATE: 01/27/14
DESIGNED BY: K. STEWART
DRAWN BY: S. VASQUEZ
CHECKED:
APPROVED:

PROCESS FLOW DIAGRAM
SHEET 1 OF 3
DWG. NO. 4001 A

Feb 17, 2014 - 8:51am P:\Active\13000\13429 - Cheniere (Northern Eagle Ford Gathering)\DRAFT\AutoCAD Sheet Set\4000 - PROCESS & MECHANICAL FLOW SHEETS\40004001 PROCESS FLOW DIAGRAM.dwg